


GENERAL MECHANICAL DEMOLITION NOTES:

- 1. MC IS RESPONSIBLE FOR DEMOLITION OF ALL EQUIPMENT AND DUCTWORK AS INDICATED.
- 2. MC CONTRACTOR TO CORRDINATE REQUIRED DEMOLITION OF MECHANICAL SYSTEMS WITH ALL OTHER TRADES..
- 3, MC TO RETURN TO OWNER ANY EQUIPMENT REMOVED AS REQUESTED BY OWNER, ANY EQUIPMENT NOT RECLAIMED BY OWNER IS TO BE DISPOSED OF BY MC.
- 4. MC IS ADVISED THAT ALL LOCATIONS ARE APPROXIMATE, VERIFY EXACT LIMITS ON SITE.
- 5. MC IS RESPONSIBLE FOR HIS OWN DEMOLITION WORK AND SHALL PROTECT EXISTING EQUIPMENT AND STRUCTURES TO REMAIN FROM DAMAGE, ANY DAMAGE INCURRED TO EXISTING EQUIPMENT TO REMAIN OR TO SURROUNDING STRUCTURE NOT INDICATED FOR DEMOLITION BY THIS CONTRACTOR IS TO BE REPAIRED AT THIS CONTRACTOR'S EXPENSE.
- 6. THESE DRAWINGS ARE NECESSARILY DIGRAMMATIC IN NATURE AND INDICATE DESIGN INTENT. NOT ALL FITTINGS, OFFSETS, VENTS, DRAINS, ETC., ARE SHOWN. CONTRACTOR SHALL PROVIDE ALL FITTINGS, OFFSETS, DRAINS, VENTS, ACCESSORIES, ETC. AS REQUIRED TO PROVIDE A COMPLETE AND FUNCTIONING SYSTEM.

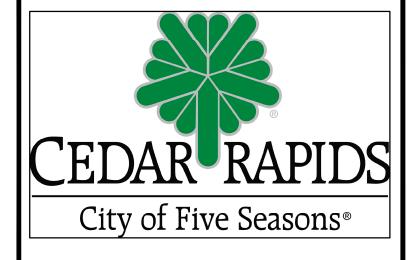

OWNER:

CITY OF CEDAR RAPIDS
Facilities Maintenance Services
City of Cedar Rapids 500 15th Ave SW, Cedar
Rapids, Iowa 52404

ENGINEER OF RECORD:



2871 Heinz Rd. Suite B, Iowa City, IA 52240 T 319.855.4115 | F 319.351.0070 www.lnnovativeEngineersInc.com

SITY OF CEDAR RAPIDS ENDER POOL HVAC PROJEC

s, IOWA 02203-01

DESIGNED BY: MNA

DRAWN BY: JJH

CHECKED BY: MNA

DOCUMENT DATE: 07-17-2018


PROJECT NO.: 18-101213


CLIENT NO.:

REVISIONS					
NO.	DATE	DESCRIPTION	BY	DWN	
0	07-17-2018	OFB DRAWINGS	MNA	JJH	
1	08-03-2018	ADDENDUM #1	MNA	JJH	

MECHANICAL-DEMOLITION




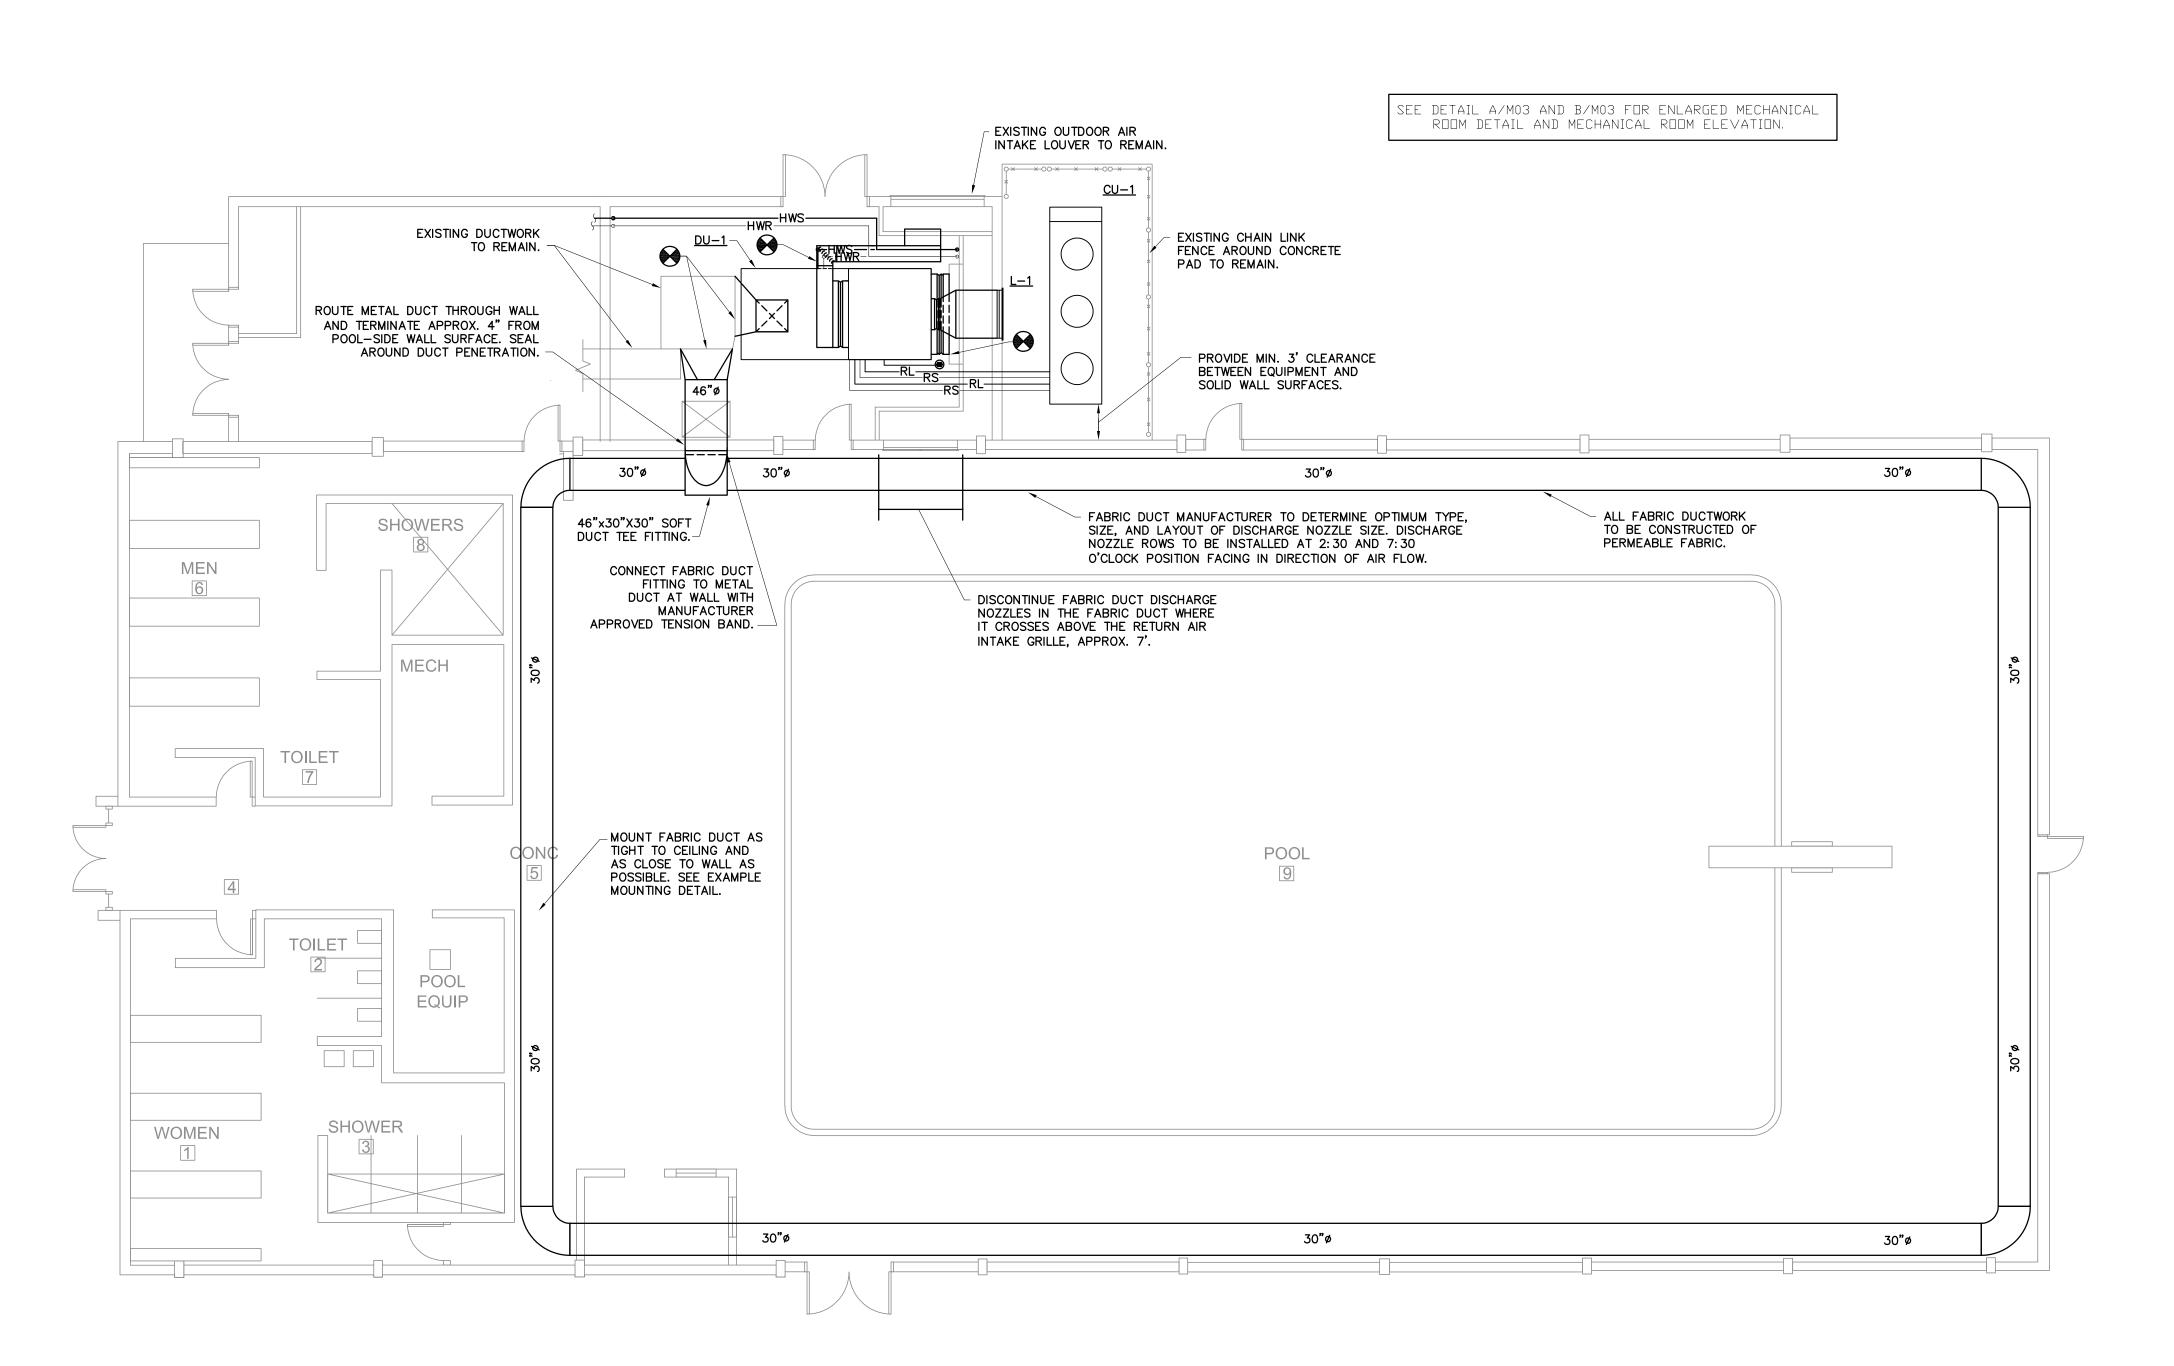

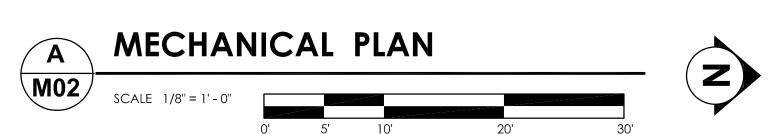

GENERAL HVAC NOTES:

- 1. MC IS RESPONSIBLE FOR INSTALLING MECHANICAL SYSTEMS ACCORDING TO ALL APPLICABLE STATE AND LOCAL CODES AND ORDINANCES.
- 2. MC TO CORRDINATE INSTALLATION OF MECHANICAL SYSTEMS WITH ALL OTHER TRADES.
- 3, MC IS ADVISED THAT ALL LOCATIONS ARE APPROXIMATE, COORDINATE FINAL LOCATIONS WITH ALL OTHER TRADES AND WITH OWNER WHERE REQUIRED.
- 5. MC IS RESPONSIBLE FOR HIS OWN WORK AND SHALL PROTECT THE WORK OF OTHER TRADES ALREADY INSTALLED FROM DAMAGE. ANY DAMAGE INCURRED TO WORK OF OTHER TRADES BY THIS CONTRACTOR'S EXPENSE.
- 6. THESE DRAWINGS ARE NECESSARILY DIGRAMMATIC IN NATURE AND INDICATE DESIGN INTENT. NOT ALL FITTINGS, OFFSETS, VENTS, DRAINS, ETC., ARE SHOWN. CONTRACTOR SHALL PROVIDE ALL FITTINGS, OFFSETS, DRAINS, VENTS, ACCESSORIES, ETC. AS REQUIRED TO PROVIDE A COMPLETE AND FUNCTIONING SYSTEM.

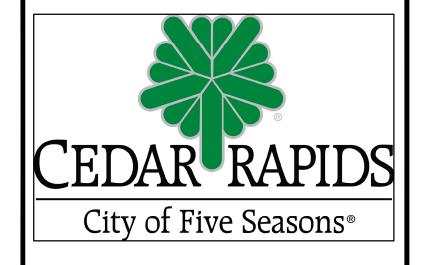

OWNE

CITY OF CEDAR RAPIDS
Facilities Maintenance Services
City of Cedar Rapids 500 15th Ave SW, Cedar
Rapids, Iowa 52404

ENGINEER OF RECORD:



2871 Heinz Rd. Suite B, Iowa City, IA 52240 T 319.855.4115 I F 319.351.0070 www.InnovativeEngineersInc.com

CITY OF CEDAR RAPIDS BENDER POOL HVAC PROJEC

DESIGNED BY: MNA

DRAWN BY: JJH

CHECKED BY: MNA

DOCUMENT DATE: 07-17-2018

PROJECT NO.: 18-101213

CLIENT NO.:

REVISIONS

NO. DATE DESCRIPTION BY DWN


0 07-17-2018 OFB DRAWINGS MNA JJH


1 08-03-2018 ADDENDUM #1 MNA JJH


PIDS, IOWA 3602203-01


CEDAR RAPROJECT

MECHANICAL-PLAN

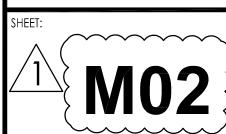

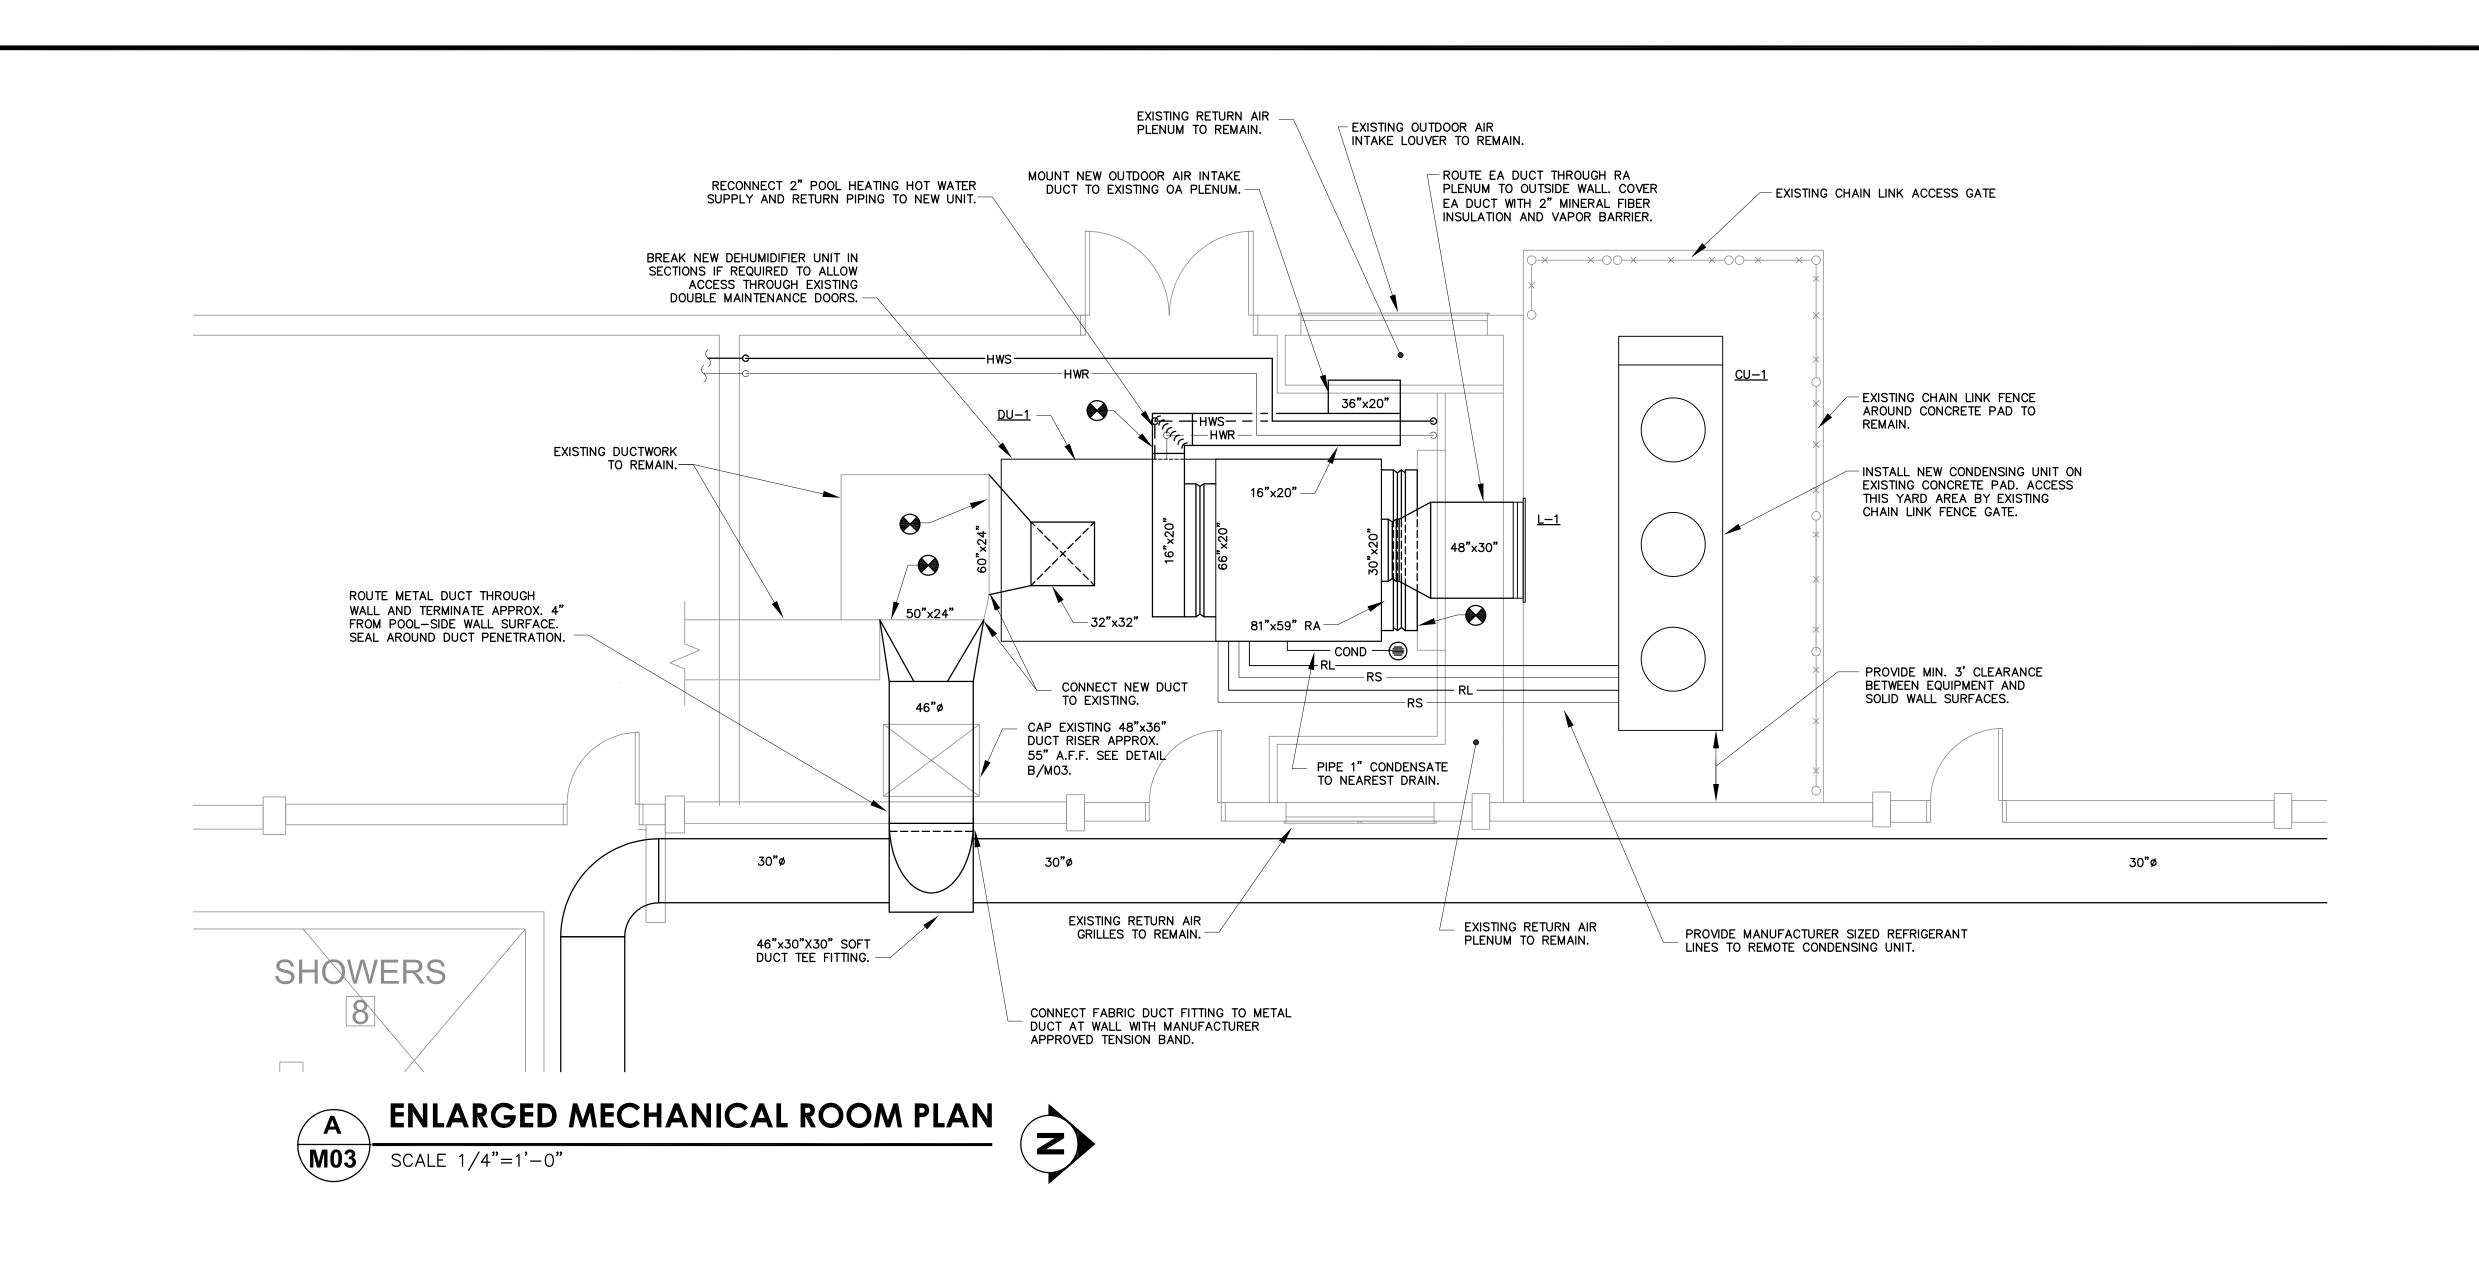

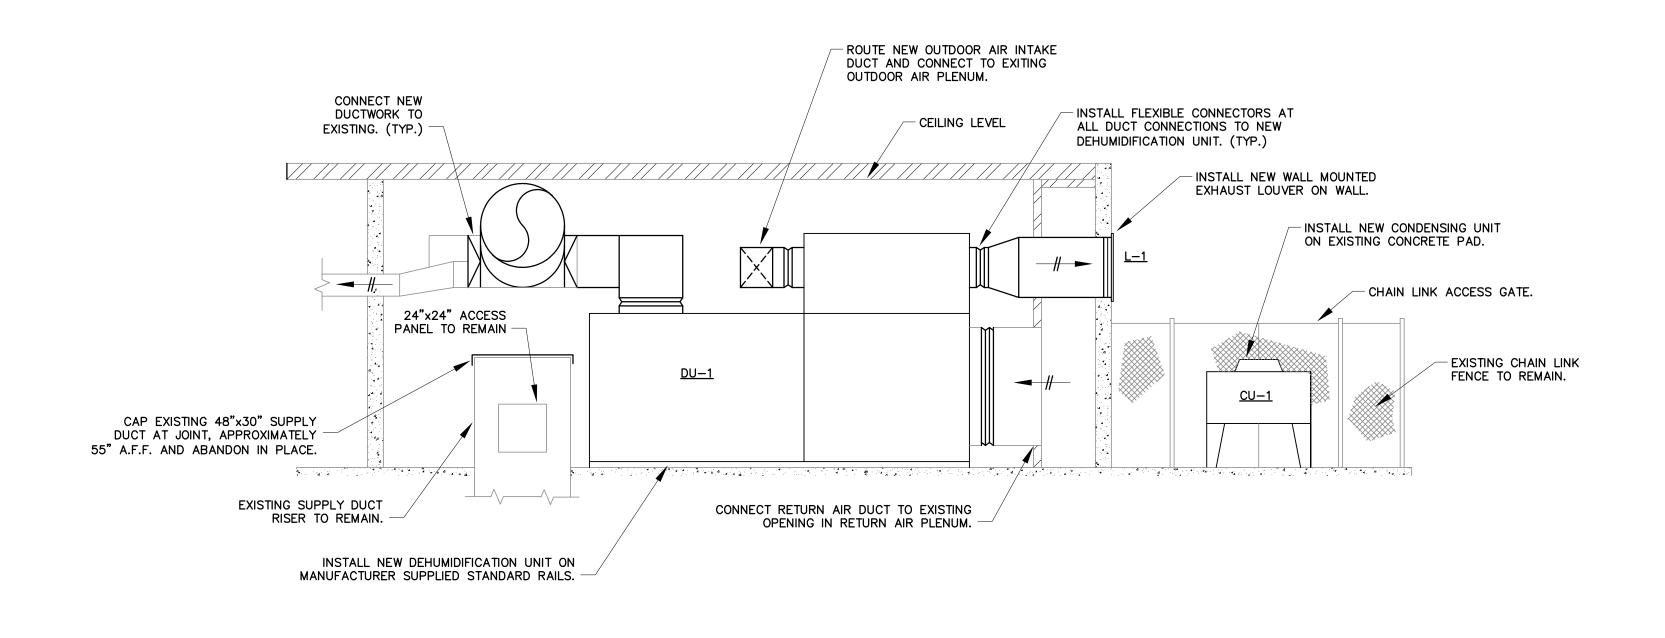

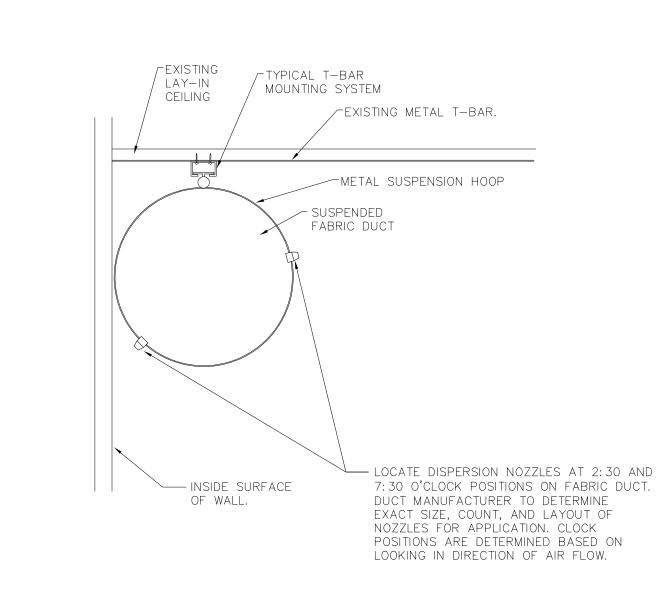

MECHANICAL ROOM ELEVATION

SCALE 1/4"=1'-0"

FABRIC DUCT DETAIL
M03 NO SCALE



OWNER:

CITY OF CEDAR RAPIDS
Facilities Maintenance Services
City of Cedar Rapids 500 15th Ave SW, Cedar
Rapids, Iowa 52404

ENGINEER OF RECORD:



2871 Heinz Rd. Suite B, Iowa City, IA 52240 T 319.855.4115 | F 319.351.0070 www.InnovativeEngineersInc.com

CITY OF CEDAR RAPIDS BENDER POOL HVAC PROJECT


DESIGNED BY: MNA
DRAWN BY: JJH
CHECKED BY: MNA
DOCUMENT DATE: 07-17-2018
PROJECT NO.: 18-101213
CLIENT NO.:

REVISIONS

s, IOWA 2203-01

NO.	DATE	DESCRIPTION	BY	DWN
0	07-17-2018	OFB DRAWINGS	MNA	JJH
1	08-03-2018	ADDENDUM #1	MNA	JJH

MECHANICAL-DETAILS

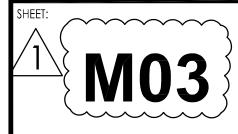


	POWER SYSTEMS
SYMBOL	DESCRIPTION
	DISTRIBUTION PANEL WITH DESIGNATION
	BRANCH PANEL WITH DESIGNATION
EF 3	MECHANICAL EQUIPMENT CONNECTION WITH DESIGNATION
\bigcirc	MOTOR WITH DESIGNATION
4	DISCONNECT SWITCH
\bigcirc	JUNCTION BOX

GENERAL ELECTRICAL NOTES

- 1. ALL WORK SHALL BE DONE IN ACCORDANCE WITH THE NATIONAL ELECTRICAL CODE (N.E.C.) AND GOVERNING MUNICIPAL, STATE AND LOCAL CODES. ALL MATERIAL SHALL BE NEW AND SHALL BEAR THE U.L. LABEL WHERE APPLICABLE.
- 2. CONTRACTOR SHALL MAKE ALL NECESSARY, CUTTING AND DO ALL THE REPATCHING AS NECESSARY FOR THE PROPER EXECUTION OF THIS WORK.
- 3. AFTER COMPLETION OF THE INSTALLATION, THE SYSTEM SHALL TEST FREE FROM SHORT CIRCUITS AND GROUNDS.
- 4. WHERE ELECTRICAL CONDUCTORS ARE INSTALLED IN CONDUIT, THE CONDUIT SHALL COMPLY WITH THE N.E.C. REQUIREMENTS.
- 5. ALL CONDUCTOR SHALL BE COPPER. NO CONDUCTOR SHALL BE SMALLER THAN #12 AWG AND SHALL BE RATED FOR 600VOLTS THWN OR THHN INSULATION. INSTALL A GROUNDING CONDUCTOR WITH ALL CIRCUITS, UNLESS NOTED OTHERWISE, SIZED PER N.E.C.250—122.
- 6. VERIFY BREAKER AND CORRESPONDING WIRE SIZES FOR ALL ELECTRICAL EQUIPMENT. DONOT ORDER MATERIAL BEFORE VERIFYING BREAKER & WIRE SIZE. REPORT ANY DISCREPANCY IMMEDIATLY TO THE ENGINEER OF RECORD.
- 7. VERIFY AVAILABLE INTERRUPTING CURRENT(AIC) WITH POWER COMPANY. EQUIPMENT AIC RATING MUST BE LARGER THAN THE POWER COMPANY AIC OR MUST BE PROTECTED ON THE LINE SIDE WITH A CURRENT LIMITING DEVICE.
- 8. SAFETY SWITCHES SHALL BE SQUARE 'D', GENERAL ELECTRIC, OR WESTINGHOUSE, FUSED OR NON-FUSED AND SIZED AS INDICATED. NEMA 3R WHEN EXPOSED TO WEATHER
- 9. PANELS SHALL BE SQUARE 'D', GENERAL ELECTRIC OR EQUAL, TYPE AND NUMBER OF BREAKERS AS INDICATED ON PANEL SCHEDULE. STENCIL PANEL DESIGNATION ON INSIDE OF PANEL. ALL TWO—POLE BREAKERS SHALL BE COMMON TRIP. PROVIDE TYPE WRITTEN SCHEDULE IN EACH LOAD CENTERS. CONNECTION TO MAIN BUS SHALL BE WITH BURNDY ANNULAR COMPRESSION LUGS.
- 10. ALL EXTERIOR ELECTRICAL EQUIPMENT SHALL BE ANCHORED TO COMPLY WITH LOCAL CODE FOR WIND RESISTANCE.
- 11. IT IS NOT THE INTENT OF THESE PLANS TO SHOW EVERY MINOR DETAIL OF CONSTRUCTION. THE CONTRACTOR IS EXPECTED TO FURNISH AND INSTALL ALL ITEMS FOR A COMPLETE ELECTRICAL SYSTEM AND PROVIDE ALL REQUIREMENTS NECESSARY FOR EQUIPMENT TO BE PLACED IN PROPER WORKING ORDER.
- 12. ALL WORK SHALL BE PERFORMED BY A LICENSED ELECTRICAL CONTRACTOR IN A FIRST CLASS WORKMANLIKE MANNER. THE COMPLETED SYSTEM SHALL BE FULLY OPERATIVE AND ACCEPTED BY THE OWNER.
- 13. LOAD DATA IS BASED ON INFORMATION GIVEN ENGINEER AT TIME OF DESIGN. VERIFY ALL EQUIPMENT AND PANEL SIZES BEFORE ORDERING AND BEFORE INSTALLATION.
- 14. ALL BRANCH CIRCUITS SHALL HAVE GROUND CONDUCTORS.
- 15. THE ELECTRICAL CONTRACTOR SHALL PROVIDE, IF REQUIRED, ADJUSTMENTS (±) 6'-0" IN THE LOCATION OF ALL SYSTEM DEVICES, FIXTURES, OUTLETS, PANELS, ETC. IN ORDER TO EXPEDITE THE ELECTRICAL WORK. THE POSITION OF ALL WORK AS SHOWN IS INTENDED TO BE FIXED AND IN THE PROPER LOCATION. SUCH REQUIRED ADJUSTMENT SHALL BE DETERMINED BY THE A/F.
- 16. PROVIDE SEPARATE NEUTRAL FOR EACH BRANCH CIRCUIT PHASE

FEEDER CONDUCTOR SIZE (75°C)				CONDUIT SIZE (EMT)							
FEEDER AMPACITY	NO. OF SETS	COPPER ALUM CONDUCTORS CONDU (THWN) (XHH		CTORS 3 PHASE CONDUCTORS				3 PHASE CONDUCTORS, NEUTRAL, AND GROUND			
		PHASE & NEUTRAL	GROUND	PHASE & NEUTRAL	GROUND	NO.	COPPER FEEDERS	ALUMINUM FEEDERS	NO.	COPPER FEEDERS	ALUMINUM FEEDERS
30	1	10	10	_	1	A1	1/2"	_	B1	1/2"	_
50	1	8	10	6	6	A2	3/4"	3/4"	B2	3/4"	1"
60	1	6	10	4	6	А3	3/4"	1"	В3	1"	1"
65	1	6	8	4	6	A4	3/4"	1"	В4	1"	1"
85	1	4	8	2	6	A5	1"	1-1/4"	B5	1-1/4"	1-1/4"
100	1	3	8	1	6	A6	1"	1-1/4"	В6	1-1/4"	1-1/4"
115	1	2	6	1/0	4	A7	1-1/4"	1-1/4"	В7	1-1/4"	1-1/2"
130	1	1	6	2/0	4	A8	1-1/4"	1-1/2"	В8	1-1/2"	2"
150	1	1/0	6	3/0	4	A9	1-1/2"	1-1/2"	В9	1-1/2"	2"
175	1	2/0	6	4/0	4	A10	1-1/2"	2"	B10	2"	2"
200	1	3/0	6	250kcmil	4	A11	2"	2"	B11	2"	2-1/2"
230	1	4/0	4	300kcmil	2	A12	2"	2"	B12	2-1/2"	2-1/2"
250	1	250kcmil	4	350kcmil	2	A13	2"	2-1/2"	B13	2-1/2"	2-1/2"
300	2	1/0	4	3/0	2	A14	1-1/2"	1-1/2"	B14	2"	2"
350	2	2/0	3	4/0	1	A15	1-1/2"	2"	B15	2"	2"
380	1	500kcmil	3	750kcmil	1	A16	2-1/2"	3"	B16	3"	3-1/2"
400	2	3/0	3	250kcmil	1	A17	2"	2"	B17	2"	2-1/2"
460	2	4/0	2	300kcmil	1/0	A18	2"	2-1/2"	B18	2-1/2"	2-1/2"
500	2	250kcmil	2	350kcmil	1/0	A19	2"	2-1/2"	B19	2-1/2"	2-1/2"
600	2	350kcmil	1	500kcmil	2/0	A20	2-1/2"	2-1/2"	B20	2-1/2"	3"
760	2	500kcmil	1/0	750kcmil	3/0	A21	2-1/2"	3"	B21	3"	3-1/2"
800	3	300kcmil	1/0	400kcmil	3/0	A22	2-1/2"	2-1/2"	B22	2-1/2"	2-1/2"


2. COORDINATE SIZE, TYPE, AND QUANTITY OF LUGS WITH EQUIPMENT VENDOR

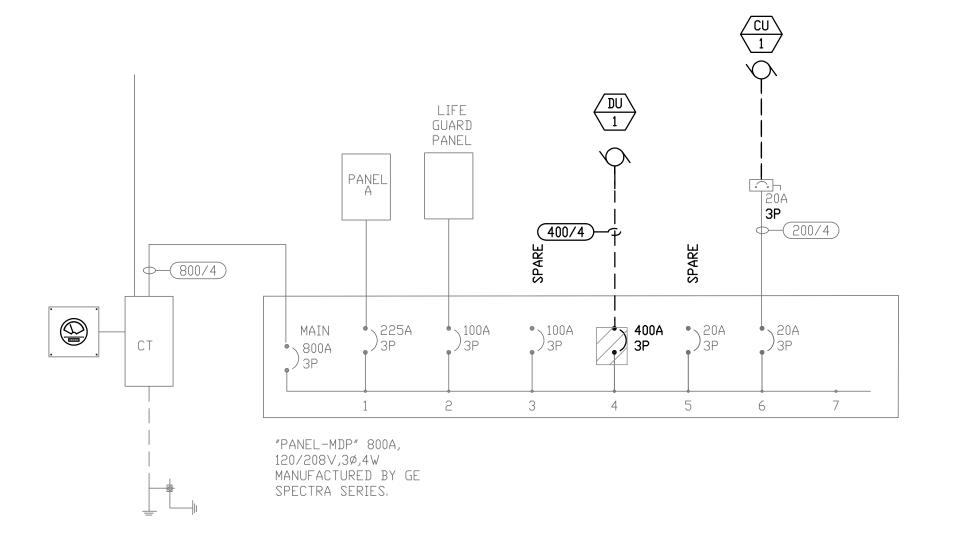



EXISTING ELECTRICAL ONE-LINE DIAGRAM

NTS

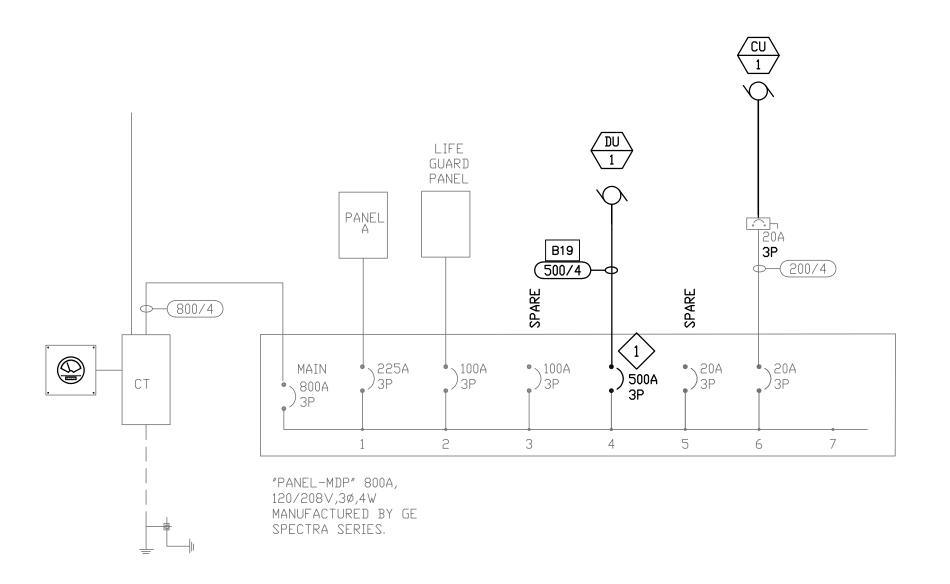



PROVIDE A 600A FRAME WITH A 500A RATING PLUG. VERIFY FRAME CAN FIT IN THE DISTRIBUTION PANEL BEFORE ORDERING.

NEW ELECTRICAL ONE-LINE DIAGRAM

NTS



OWNER:

CITY OF CEDAR RAPIDS
Facilities Maintenance Services
City of Cedar Rapids 500 15th Ave SW, Cedar
Rapids, Iowa 52404

ENGINEER OF RECORD:



2871 Heinz Rd. Suite B, Iowa City, IA 52240 T 319.855.4115 | F 319.351.0070 www.InnovativeEngineersInc.com

CITY OF CEDAR RAPIDS BENDER POOL HVAC PROJEC

DESIGNED BY: MNA

DRAWN BY: JJH

CHECKED BY: MNA

DOCUMENT DATE: 07-17-2018

PROJECT NO.: 18-101213

CLIENT NO.:

PIDS, IOWA 3602203-01

REVISIONS							
NO.	DATE	DESCRIPTION	ВҮ	DWN			
0	07-17-2018	OFB DRAWINGS	MNA	JJH			
1	08-03-2018	ADDENDUM #1	MNA	JJH			

ELECTRICAL ONE-LINE & NOTES

